




**A**  
SCALE 1:50  
**SECTION A-A**

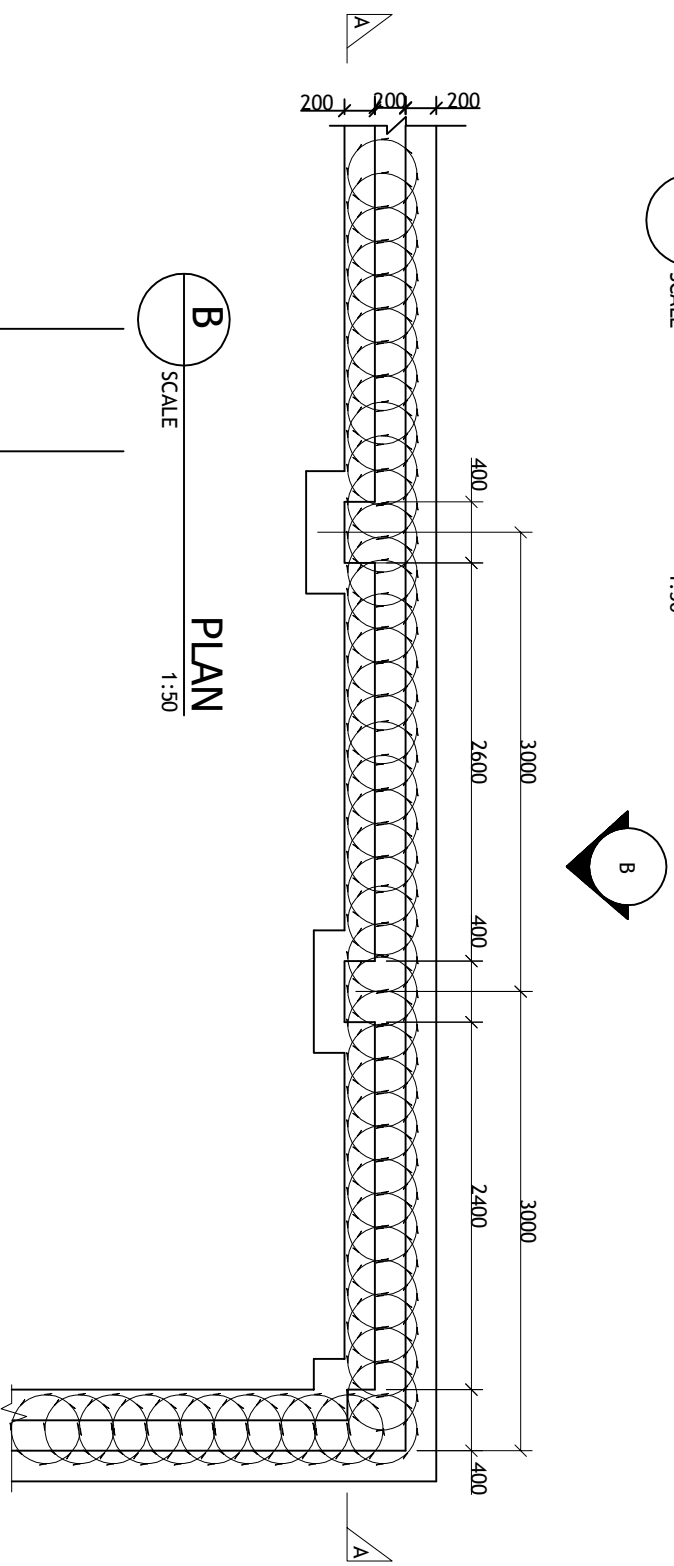


**B**  
SCALE 1:50  
**PLAN**

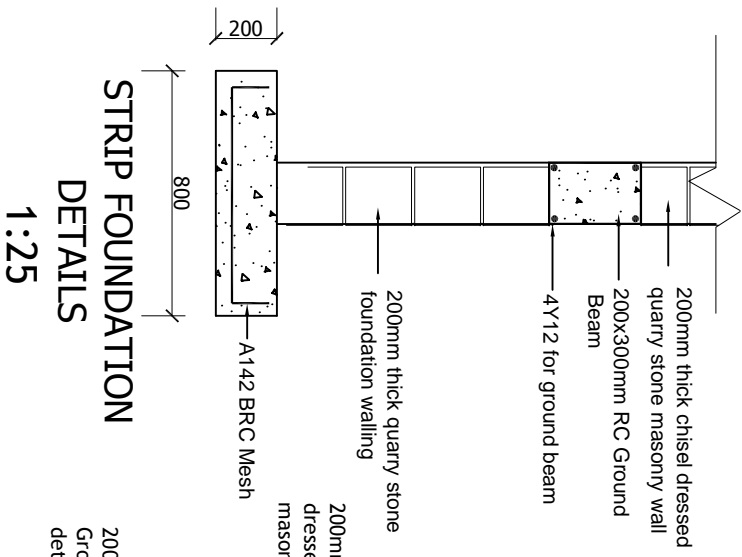


**STRIP FOUNDATION DETAILS**  
1:25

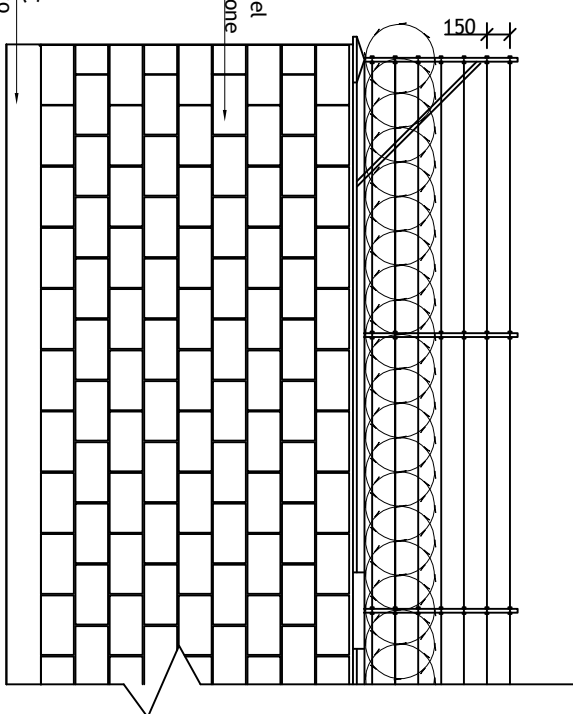

**C**  
SCALE 1:50  
**EXTERNAL ELEVATION B**

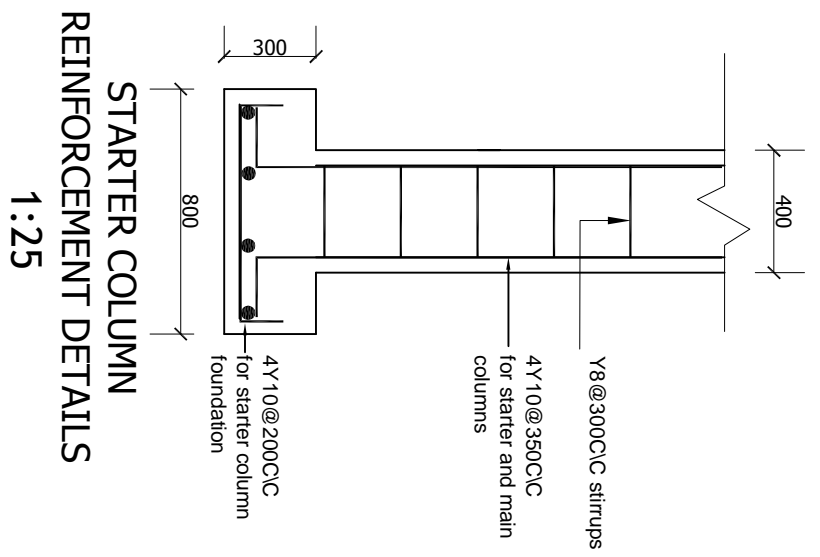


**STARTER COLUMN REINFORCEMENT DETAILS**  
1:25

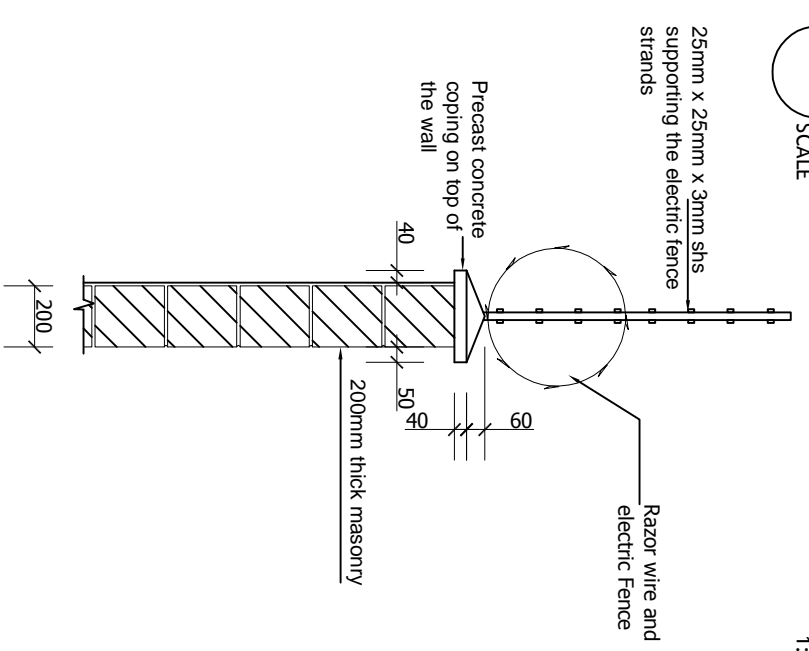

**D**  
SCALE 1:25  
**DETAIL D**

**GROUND BEAM REINFORCEMENT DETAILS**  
1:25

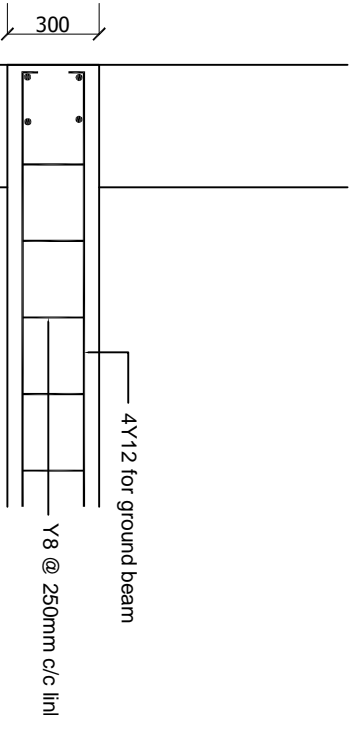


MINISTRY OF TRANSPORT, INFRASTRUCTURE,  
HOUSING & URBAN DEVELOPMENT  
STATE DEPARTMENT OF INFRASTRUCTURE  
Materials Testing & Research Division


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SITE NAME	MTRD	DRAWN	JW
SITE CODE		CHECKED	TA
LOCATION	HQ, NAIROBI	APPROVED	CEM
SHEET NO.	1 OF 2	DATE	27 FEB 17

ISSUE NO.	REVISION	BY	DATE


LANDLORD DETAILS	
NAME	
L/R NUMBER	
ADDRESS	
PHONE	

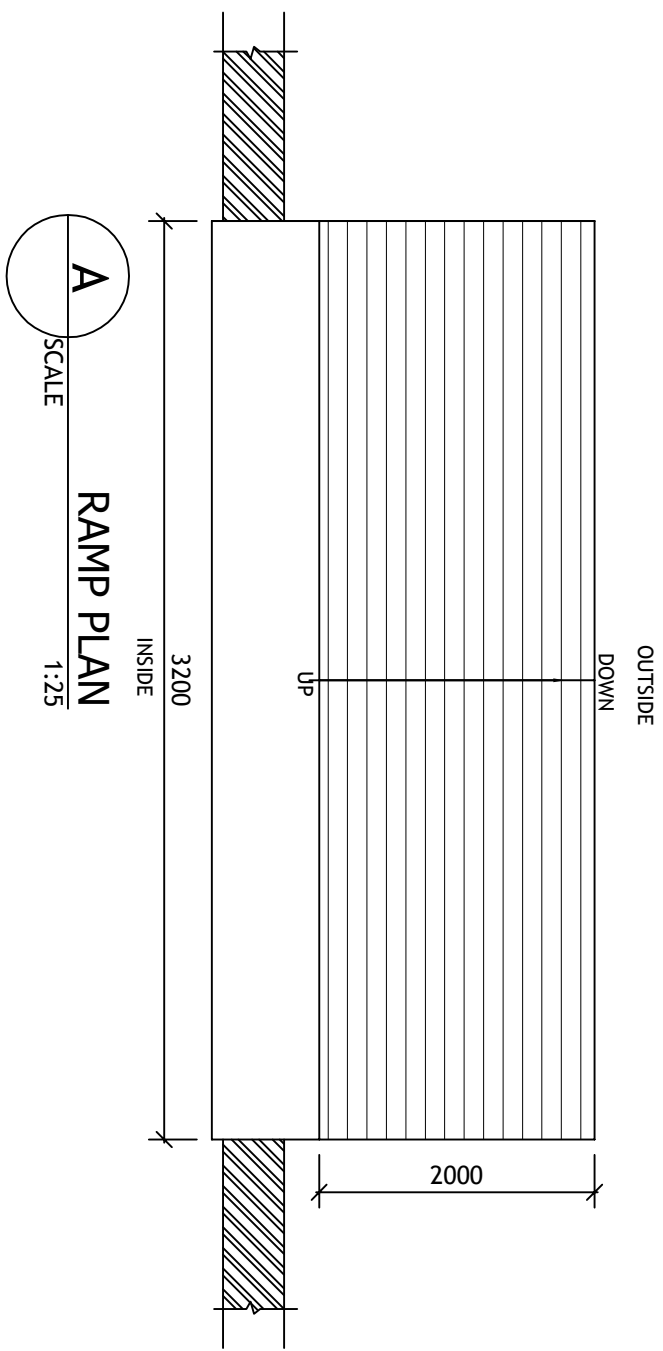

**A**  
SCALE 1:25  
**RAMP PLAN**

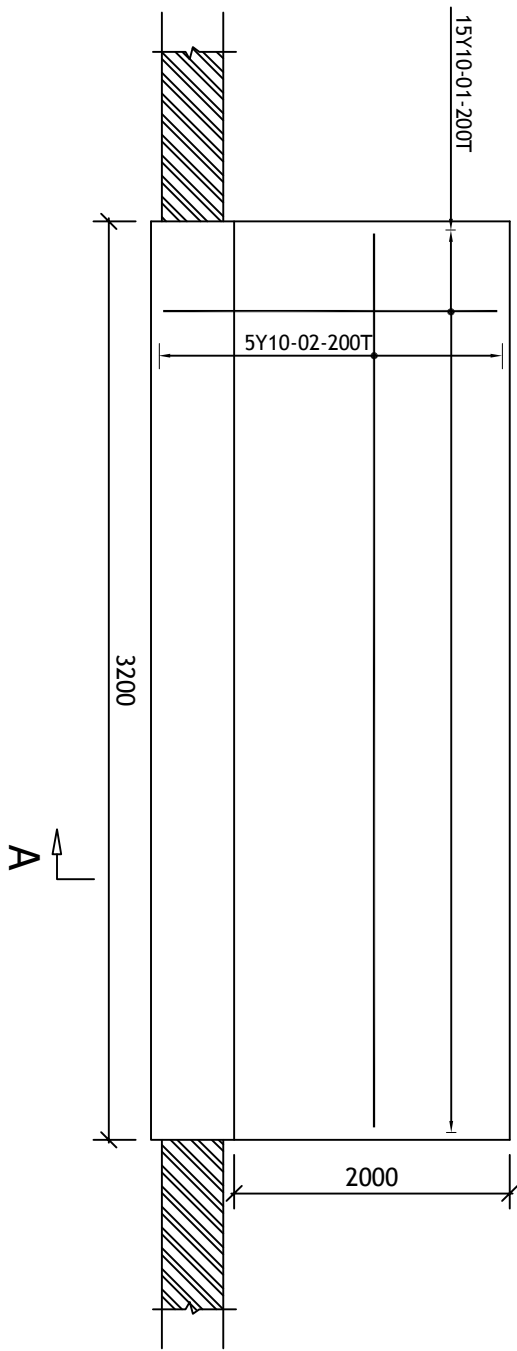

**B**  
SCALE 1:25  
**REINFORCEMENT PLAN**

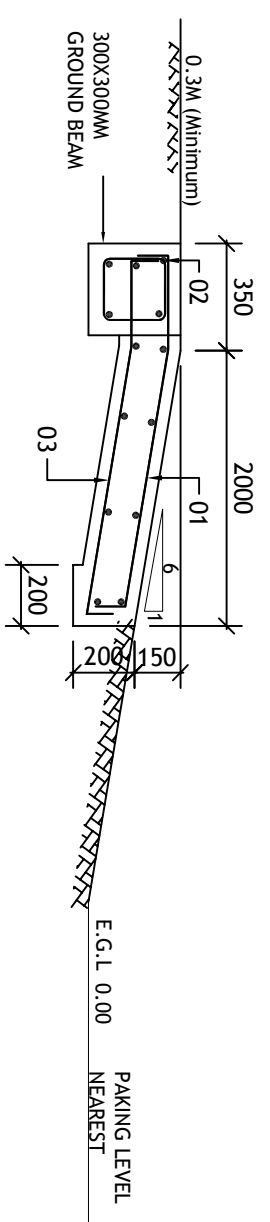

**C**  
SCALE 1:25  
**SECTION A-A**

- NOTES**
1. ALL DIMENSIONS IN MM UNLESS NOTED OTHERWISE
  2. FOLLOWING CONCRETE GRADE SHALL BE USED  
RAMP SLAB - CLASS 25
  3. MINIMUM AGGREGATE SIZE SHALL BE 20MM.
  4. CLEAR CONCRETE COVER SHALL BE 50MM
  5. SOIL TO BE COMPACTED TO PRODUCE INSITU DENSITY NOT LESS THAN 95% OF THE MAX MODIFIED DRY AASHTO DENSITY CONFORMING TO T-180 OF AASHTO
  6. THIS IS GENERIC DRAWING SHALL BE IMPLEMENTED BASED ON SITE CONDITIONS AND SHALL BE MODIFIED IN ACCORDANCE WITH ACTUAL SITE REQUIREMENTS

ACCESS RAMP FOR PWDS				DRAWING DETAILS		LANDLORD DETAILS	
SITE NAME	MTRD	DRAWN	JW	ISSUE NO.	REVISION	BY	DATE
MINISTRY OF TRANSPORT, INFRASTRUCTURE, HOUSING & URBAN DEVELOPMENT		CHECKED	TA				
STATE DEPARTMENT OF INFRASTRUCTURE	HQ, NAIROBI	APPROVED	CEM				
Materials Testing & Research Division	2 OF 2	DATE	27 FEB 17				